

PRECAST REINFORCEMENT SCHEDULE

PANELS	THICKNESS	FABRIC	VERT. REINF.	HORIZ. REINF.	PERIMETER BARS	DOWELS BTM. EDGE*
P1	200	SL92 EF	-	-	N16 EF	D2-500 CTS
P2	150	SL102 CENTRAL	-	-	=	D2-500 CTS
P3	150	-	N12-200 CENTRAL	N12-200 CENTRAL	=	D2-500 CTS
P4	150	-	N16-200 CENTRAL	N16-200 CENTRAL	=	D2-500 CTS
P4a	150	-	N16-200 CENTRAL	N16-200 CENTRAL	=	D3-400 CTS
P4b	150	-	N16-200 CENTRAL	N16-200 CENTRAL	=	D4-400 CTS
P5	150	-	N20-200 CENTRAL	N20-200 CENTRAL	=	D3-400 CTS
P5a	150	-	N20-200 CENTRAL	N20-200 CENTRAL	=	D4-400 CTS
P6	200	-	N12-200 EF	N12-200 EF	=	D3-400 CTS
P6a	200	-	N12-200 EF	N12-200 EF	=	D2-500 CTS
P7	200	-	N16-200 EF	N16-200 EF	=	D4-400 CTS
P7a	200	-	N16-200 EF	N16-200 EF	=	D3-400 CTS
P8	200	SL92 EF	-	-	=	D2-500 CTS
P9	200	-	N20-200 EF	N20-200 EF	=	D4-400 CTS

Designer	RW	Drawn	82 & MM
Approved	Approver	Date	02/07/2019 1:02:11 PM
		Sheet	


Project
**HYDE PARK PLACE
248 UNLEY ROAD,
HYDE PARK SA**

Client
CITYFY & BFC PTY LTD


Drawing Title
**INTERNAL ELEVATION
ON GRID E (Sheet 4)**

Drawing Number
20492-S19

TENDER ISSUE

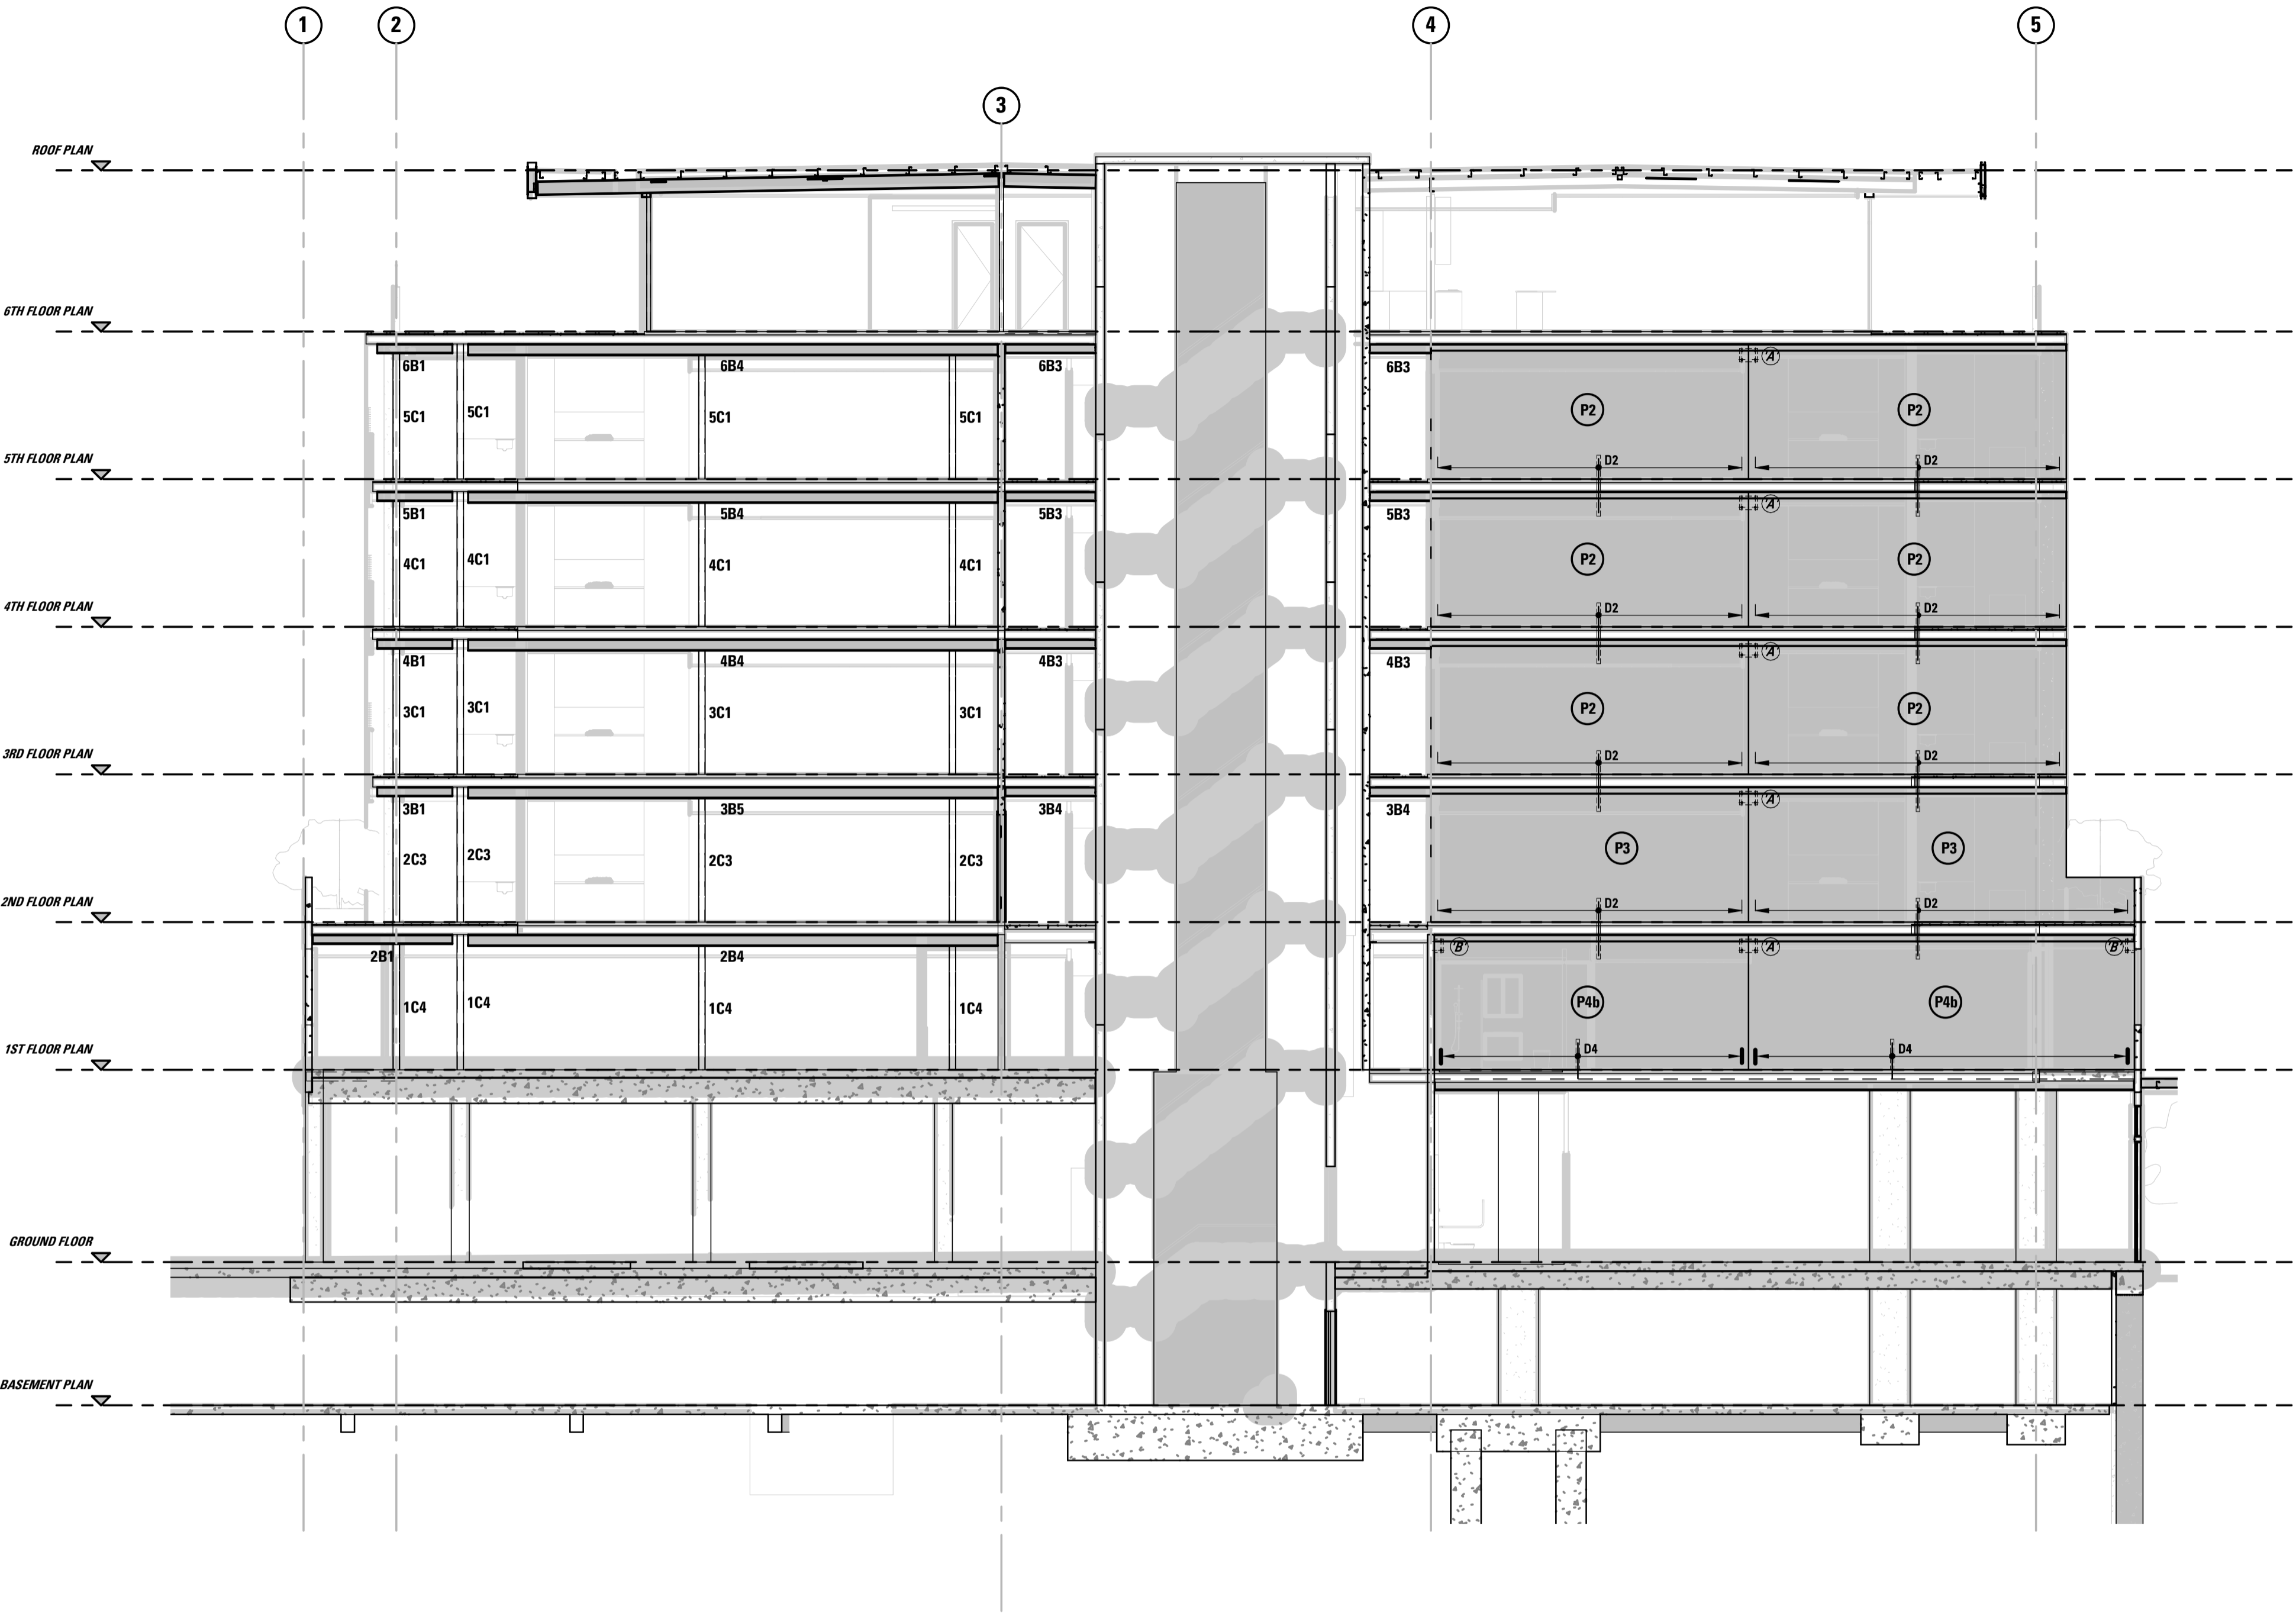

INTERNAL PRECAST ELEVATION ALONG GRID-E
SCALE 1:100

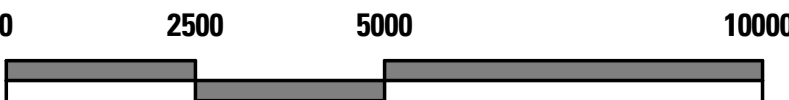

SCALE 1:100 @ A1